
#### **PROJECT**


PROPOSED CONSTRUCTION OF SEED STORAGE IN GREATER YEI

# IMPLEMENTED BY ACROSS SOUTH SUDAN

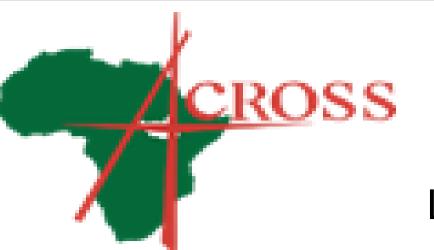

Drawn by;
Isaac Kibo Alfred
Checked by
Levi Mogga Yonna

Drawing Scale 1:1000mm

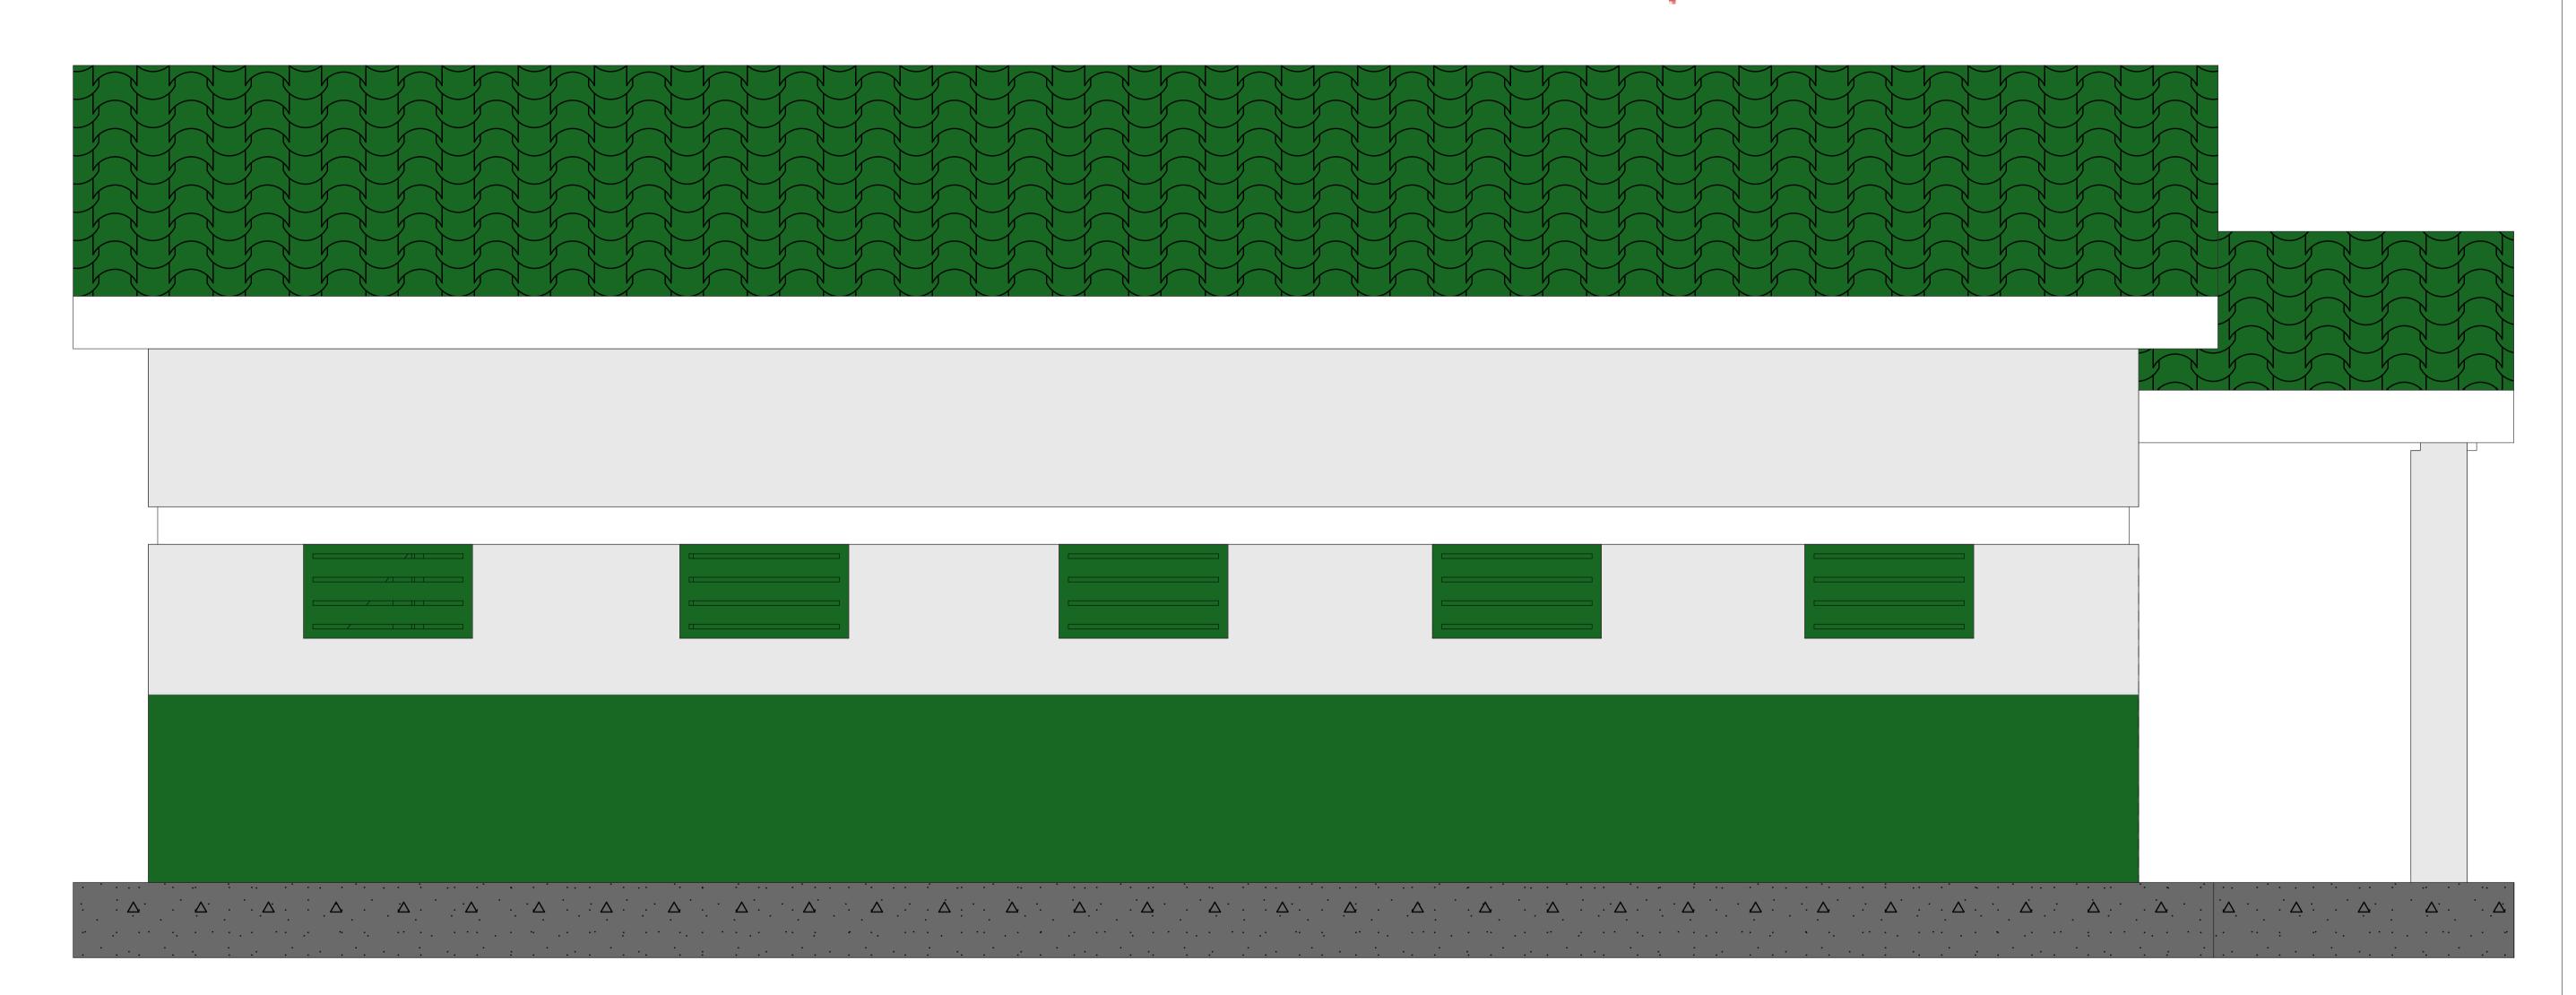

# REAR ELEVATION

## **FOUNDATION DETAIL**

200mm screeding steel float smoothened with mirrow grouting joints with white cement.

-100mm plain insitu oversite concrete 1:3:6,20mm agg class on DPM Layer 1000 gauge polythene sheet on 50mm sand blinding and BRC.

-230mm plith wall on 550x150mm footing concrete 1:3:6, 20mm agg N B DPC 150mm above ground level.

The depth shall be determined at the site depending on the soil texture conditions.

### WINDOW AND DOOR SCHEDULE

S/NO	SYMBOL	NO	DIMENSIONS	DESCRIPTION
1	W1	7	900mm x 500mm	Steel casement window top hung sush with Louvored tinted glass
2	D2	1	900mm x 2100mm	Steel casement door with plate, fix louvre on top
3	<b>D</b> 1	1	2000mm x 2100mm	Steel store double door with plate, fix louvre on top